


HABS Wireless Station Laser Scan


Draft Set May 2018

Incorporated by reference as **Appendix F** to the Government Hill Wireless Station Historic Structure Report

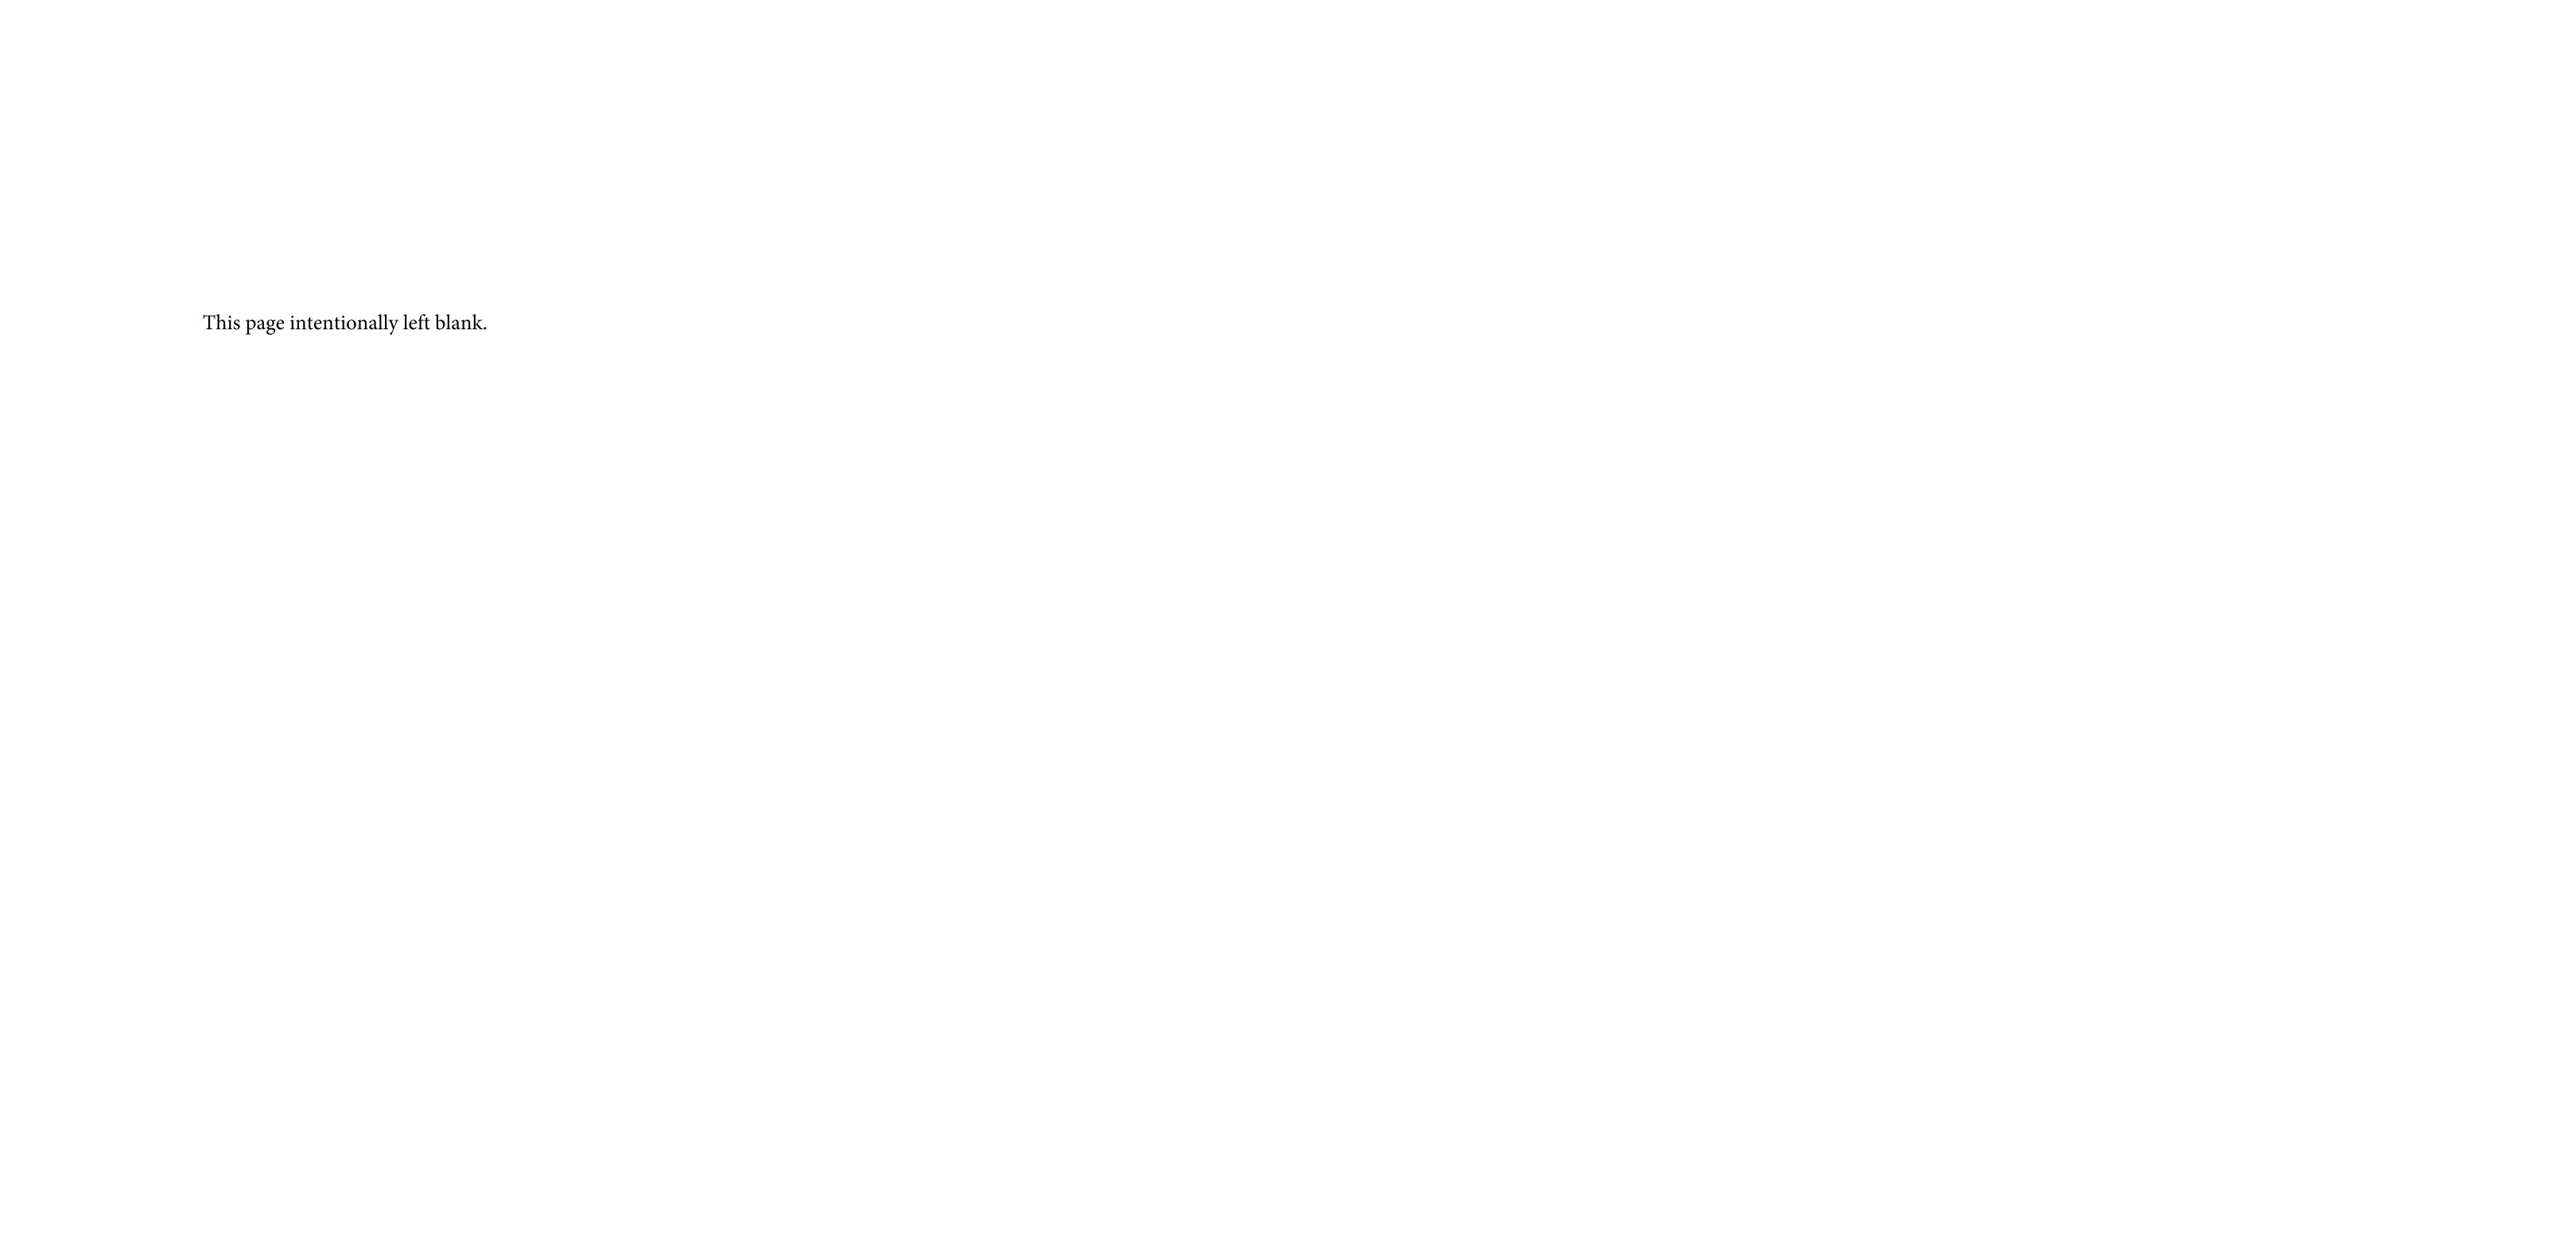

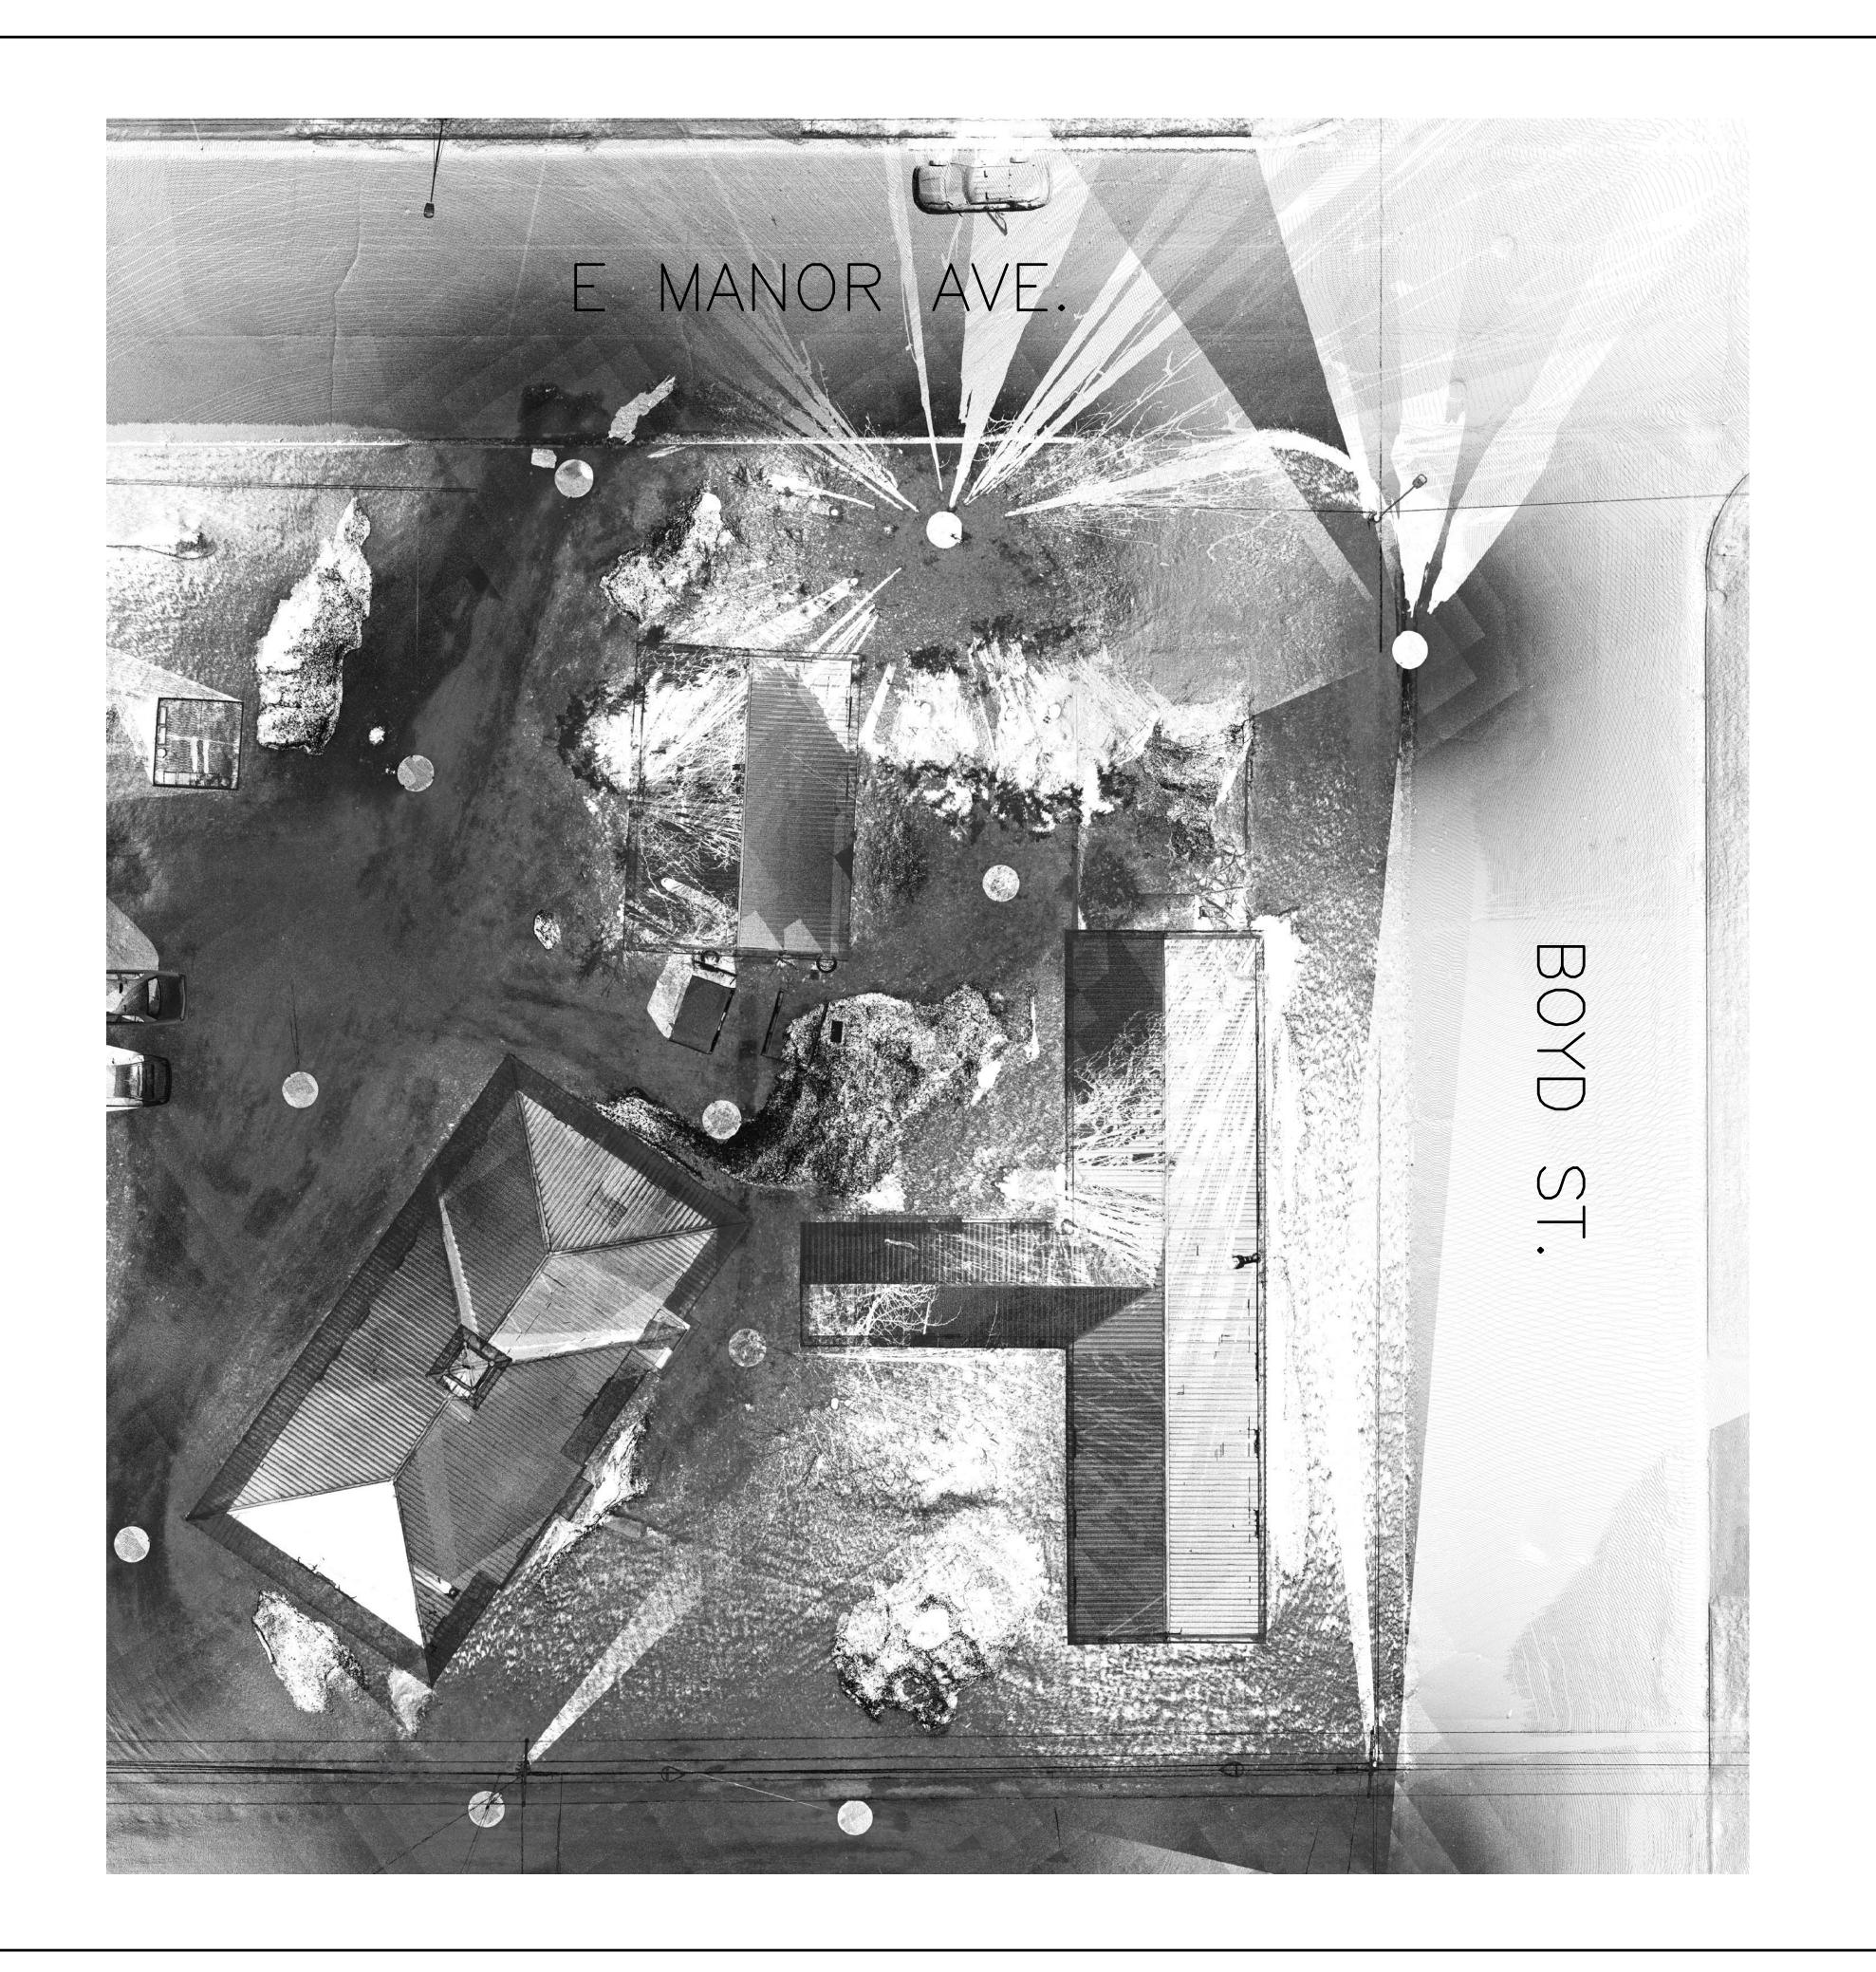

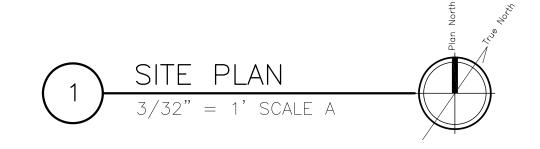


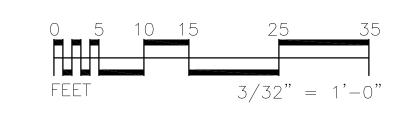

SHEET NOTES

DESIGNED:	SUB SHEET NO.	Wireless Station	DRAWING NO.
		Site Plan	
CCL PENIEW	1 1	Site i idii	PMIS/PKG NO.
TECH. REVIEW:			
JMW	•		SHEET
DATE: 5/4/2018		Anchorage, ALASKA	_1_ of 14_




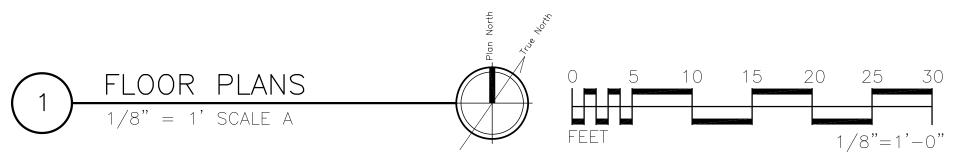

SHEET NOTES

- NOTE THIS IS POINT CLOUD DATA DERIVED FROM A HIGH DEFINITION LASER SCANNER. SOME PORTIONS OF BUILDINGS WERE OBSCURED BY NEARBY VEGETATION AND AS A RESULT, CREATE THE APPEARANCE OF "SHADOWS" CAST AGAINST THE BUILDING'S SURFACES. THIS IS A COMMON CHARACTERISTIC OF LASER SCAN DATA AND IT SHOULD NOT BE MISINTERPRETED AS PHYSICAL FEATURES OF THE BUILDINGS.
 INTERIOR SCAN DATA WAS NOT COLLECTED. PLANS SIMPLY SHOW SECTION CUT REMOVING ROOF DATA.


DESIGNED:	SUB SHEET NO.	Wreless Station	DRAWING NO.
CCL ECH. REVIEW:	1 7	Floor Plans	PMIS/PKG NO.
IMW	•		SHEET
DATE: 5/4/2018		Anchorage, ALASKA	_2_ of 14

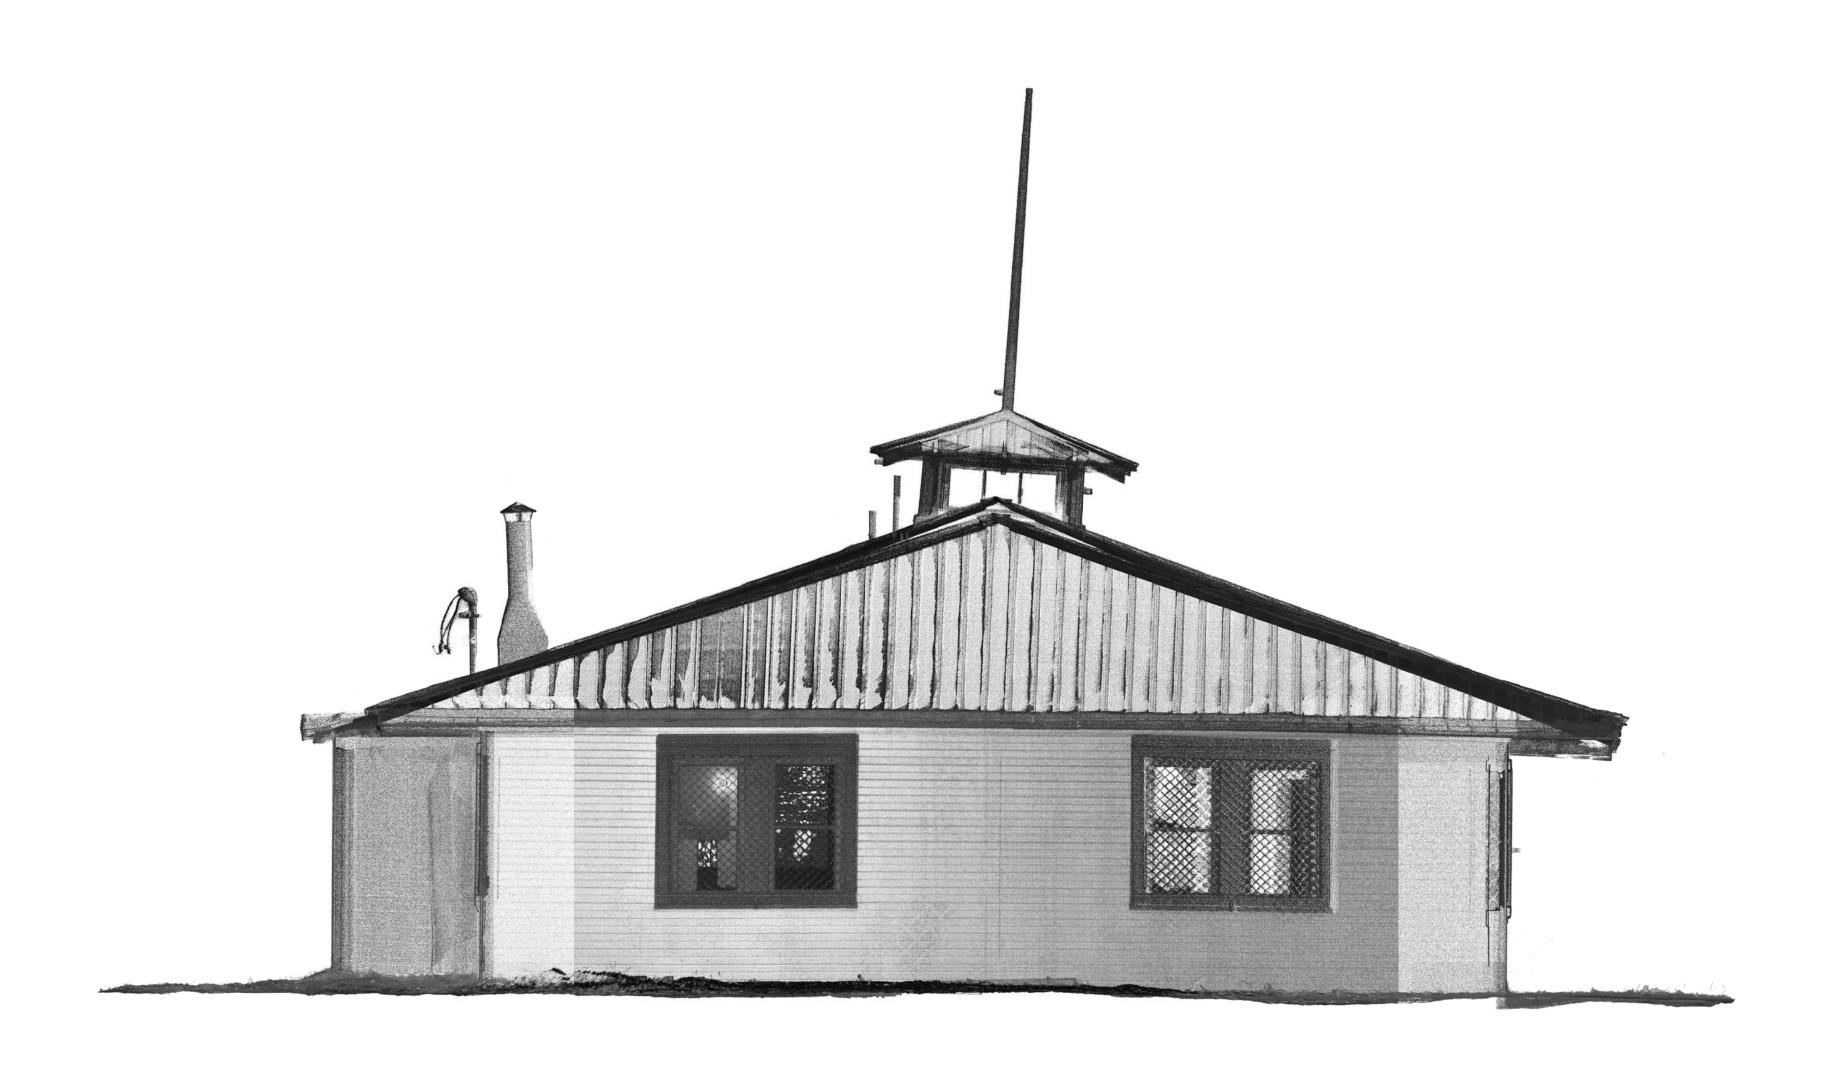

NORTH ELEVATION


3/8" = 1' SCALE A

*NOTE: WIRELESS BUILDING ALIGNED TO TRUE NORTH, UNLIKE SURROUNDING STRUCTURES

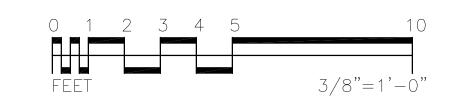

SHEET NOTES

DESIGNED:	SUB SHEET NO.	Wireless Station	DRAWING NO.
CCL TECH. REVIEW:	1 3	Wireless Building North Elevation	PMIS/PKG NO.
JMW		NOTH LIEVATION	SHEET
DATE: 5/4/2018		Anchorage, ALASKA	3 of 14

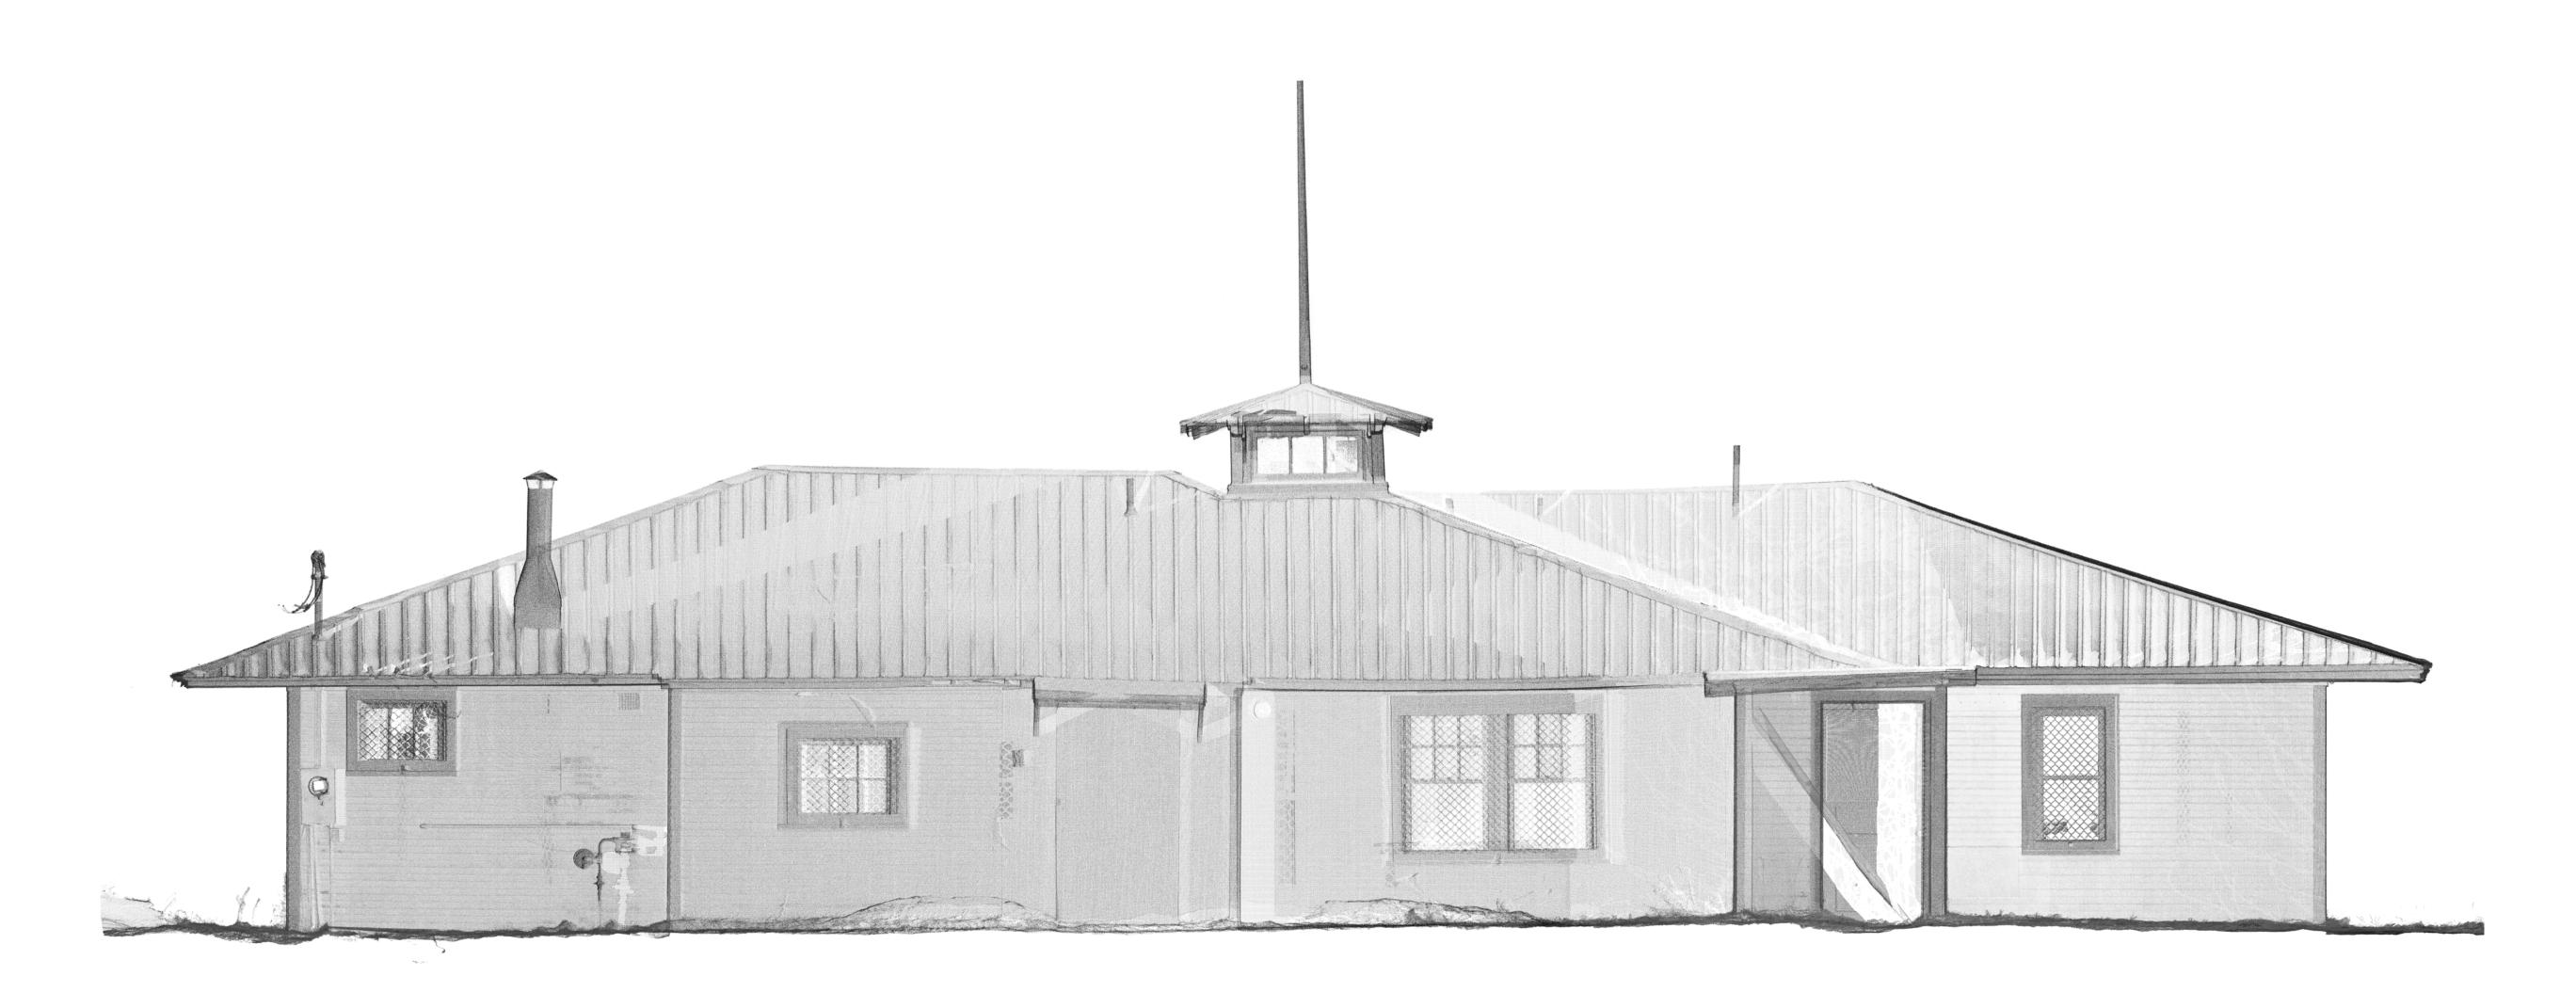




EAST ELEVATION

3/8" = 1' SCALE A

*NOTE: WIRELESS BUILDING ALIGNED TO TRUE NORTH, UNLIKE SURROUNDING STRUCTURES

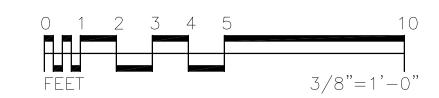

SHEET NOTES

1. NOTE THIS IS POINT CLOUD DATA DERIVED FROM A HIGH DEFINITION LASER SCANNER. SOME PORTIONS OF BUILDINGS WERE OBSCURED BY NEARBY VEGETATION AND AS A RESULT, CREATE THE APPEARANCE OF "SHADOWS" CAST AGAINST THE BUILDING'S SURFACES. THIS IS A COMMON CHARACTERISTIC OF LASER SCAN DATA AND IT SHOULD NOT BE MISINTERPRETED AS PHYSICAL FEATURES OF THE BUILDINGS.

DESIGNED:	SUB SHEET NO.	Wireless Stat
CCL	1 1	Wireless Build
TECH. REVIEW: JMW	.4	East Elevation
DATE: 5/4/2018		Anchorage, ALASKA

Wireless Station
Wireless Building
East Elevation


Anchorage, ALASKA

DRAWING NO.

PMIS/PKG NO.

SHEET


4 OF 14

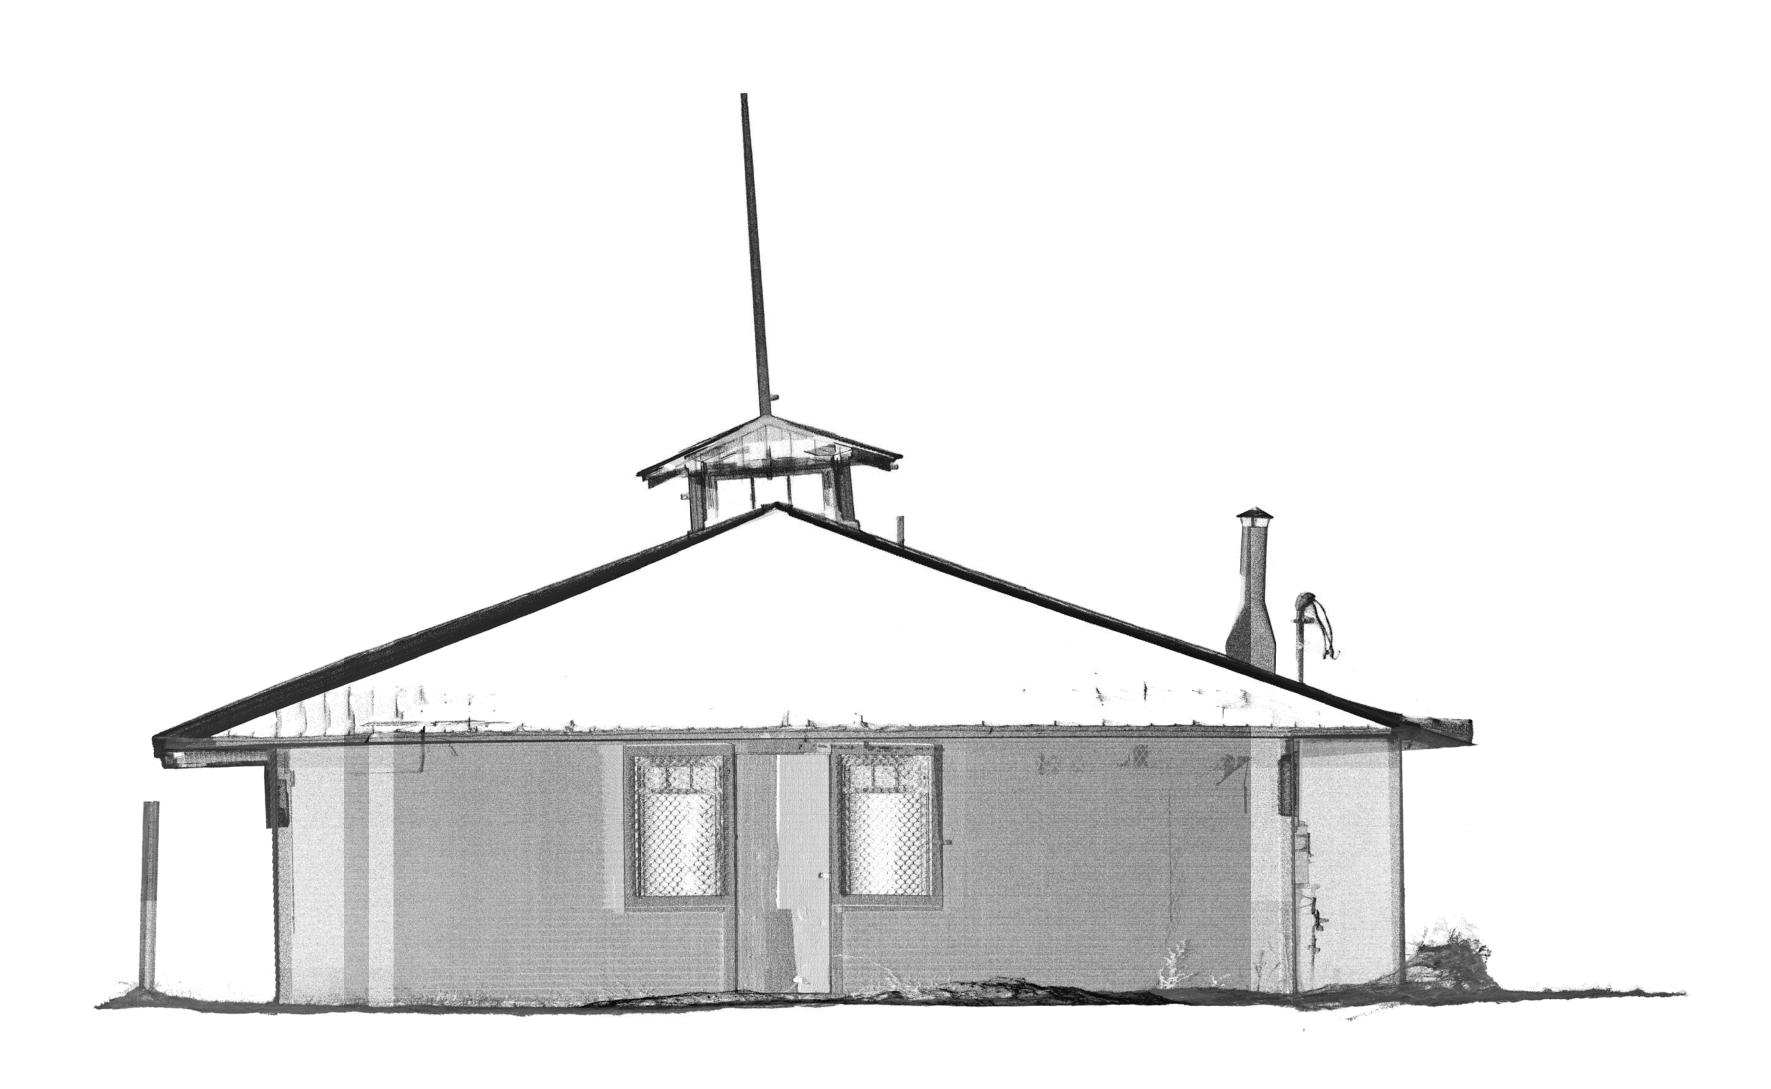

SOUTH ELEVATION

3/8" = 1' SCALE A

*NOTE: WIRELESS BUILDING ALIGNED TO TRUE NORTH, UNLIKE SURROUNDING STRUCTURES

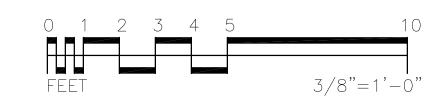


SHEET NOTES

1. NOTE THIS IS POINT CLOUD DATA DERIVED FROM A HIGH DEFINITION LASER SCANNER. SOME PORTIONS OF BUILDINGS WERE OBSCURED BY NEARBY VEGETATION AND AS A RESULT, CREATE THE APPEARANCE OF "SHADOWS" CAST AGAINST THE BUILDING'S SURFACES. THIS IS A COMMON CHARACTERISTIC OF LASER SCAN DATA AND IT SHOULD NOT BE MISINTERPRETED AS PHYSICAL FEATURES OF THE BUILDINGS.

2. NOTE A PORTION OF THE ROOF INFORMATION IS MISSING BECAUSE IT WAS UNABLE TO BE OBTAINED

DESIGNED:	SUB SHEET NO.	Wireless Station	DRAWING NO.
CCL		Wireless Building	PMIS/PKG NO.
TECH. REVIEW: JMW		South Elevation	SHEET
DATE: 5/4/2018		Anchorage, ALASKA	_5_ of 14_

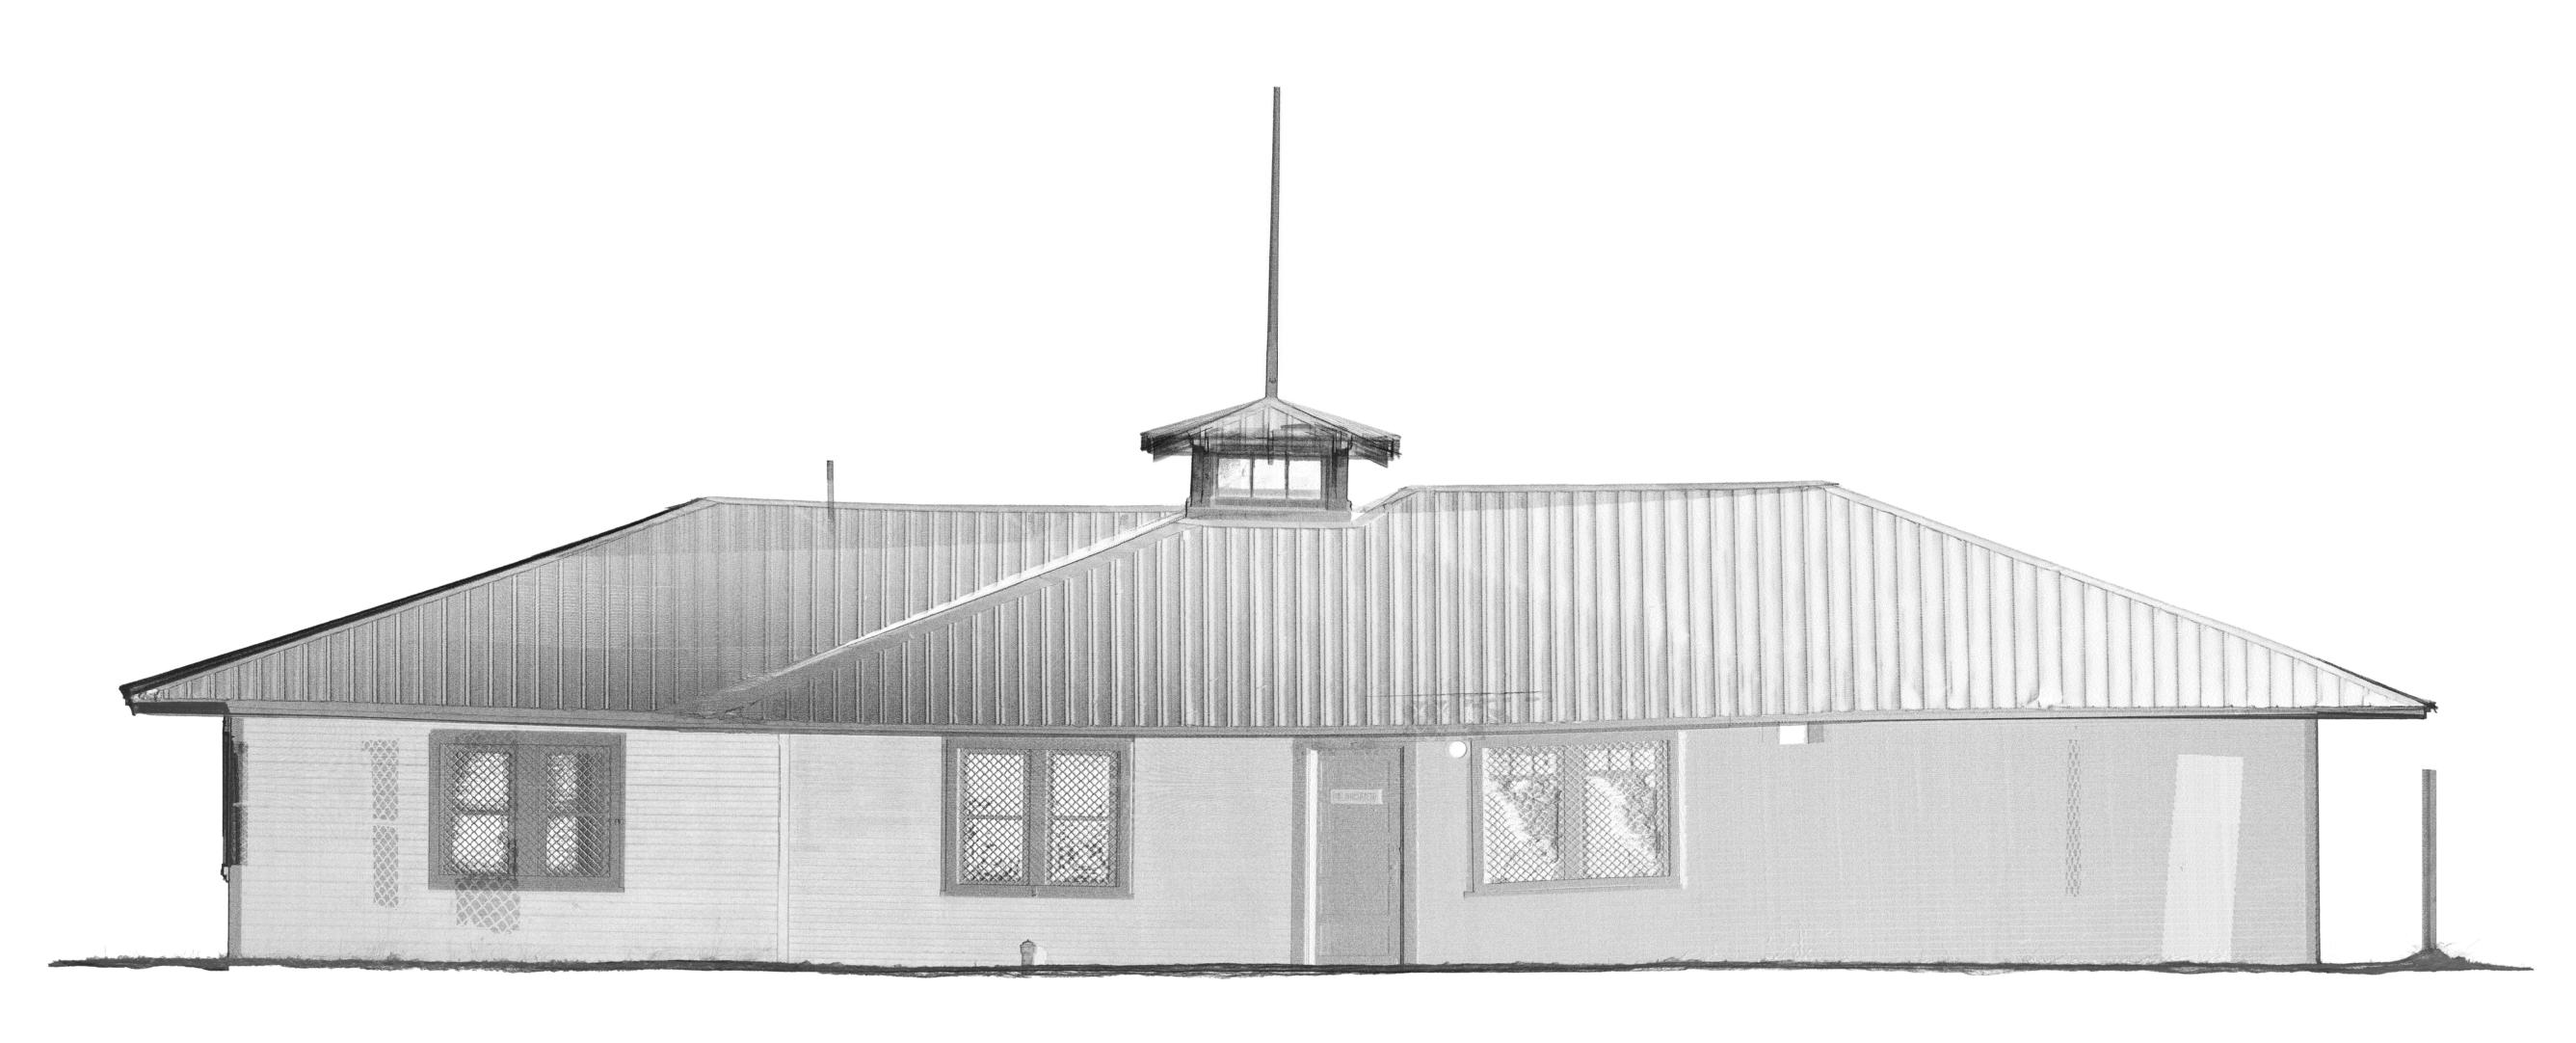


 \bigcirc 1

WEST ELEVATION

3/8" = 1' SCALE A

*NOTE: WIRELESS BUILDING ALIGNED TO TRUE NORTH, UNLIKE SURROUNDING STRUCTURES

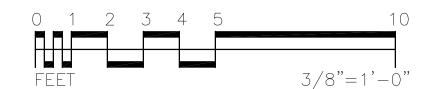

SHEET NOTES

1. NOTE THIS IS POINT CLOUD DATA DERIVED FROM A HIGH DEFINITION LASER SCANNER. SOME PORTIONS OF BUILDINGS WERE OBSCURED BY NEARBY VEGETATION AND AS A RESULT, CREATE THE APPEARANCE OF "SHADOWS" CAST AGAINST THE BUILDING'S SURFACES. THIS IS A COMMON CHARACTERISTIC OF LASER SCAN DATA AND IT SHOULD NOT BE MISINTERPRETED AS PHYSICAL FEATURES OF THE BUILDINGS.


DESIGNED:	SUB SHEET NO.	Wiewless Station
CCL	1	Wireless Building
TECH. REVIEW:	11.6	West Elevation
DATE: 5/4/2018		Anchorage, ALASKA

DRAWING NO.

PMIS/PKG NO.

SHEET

6 of <u>14</u>

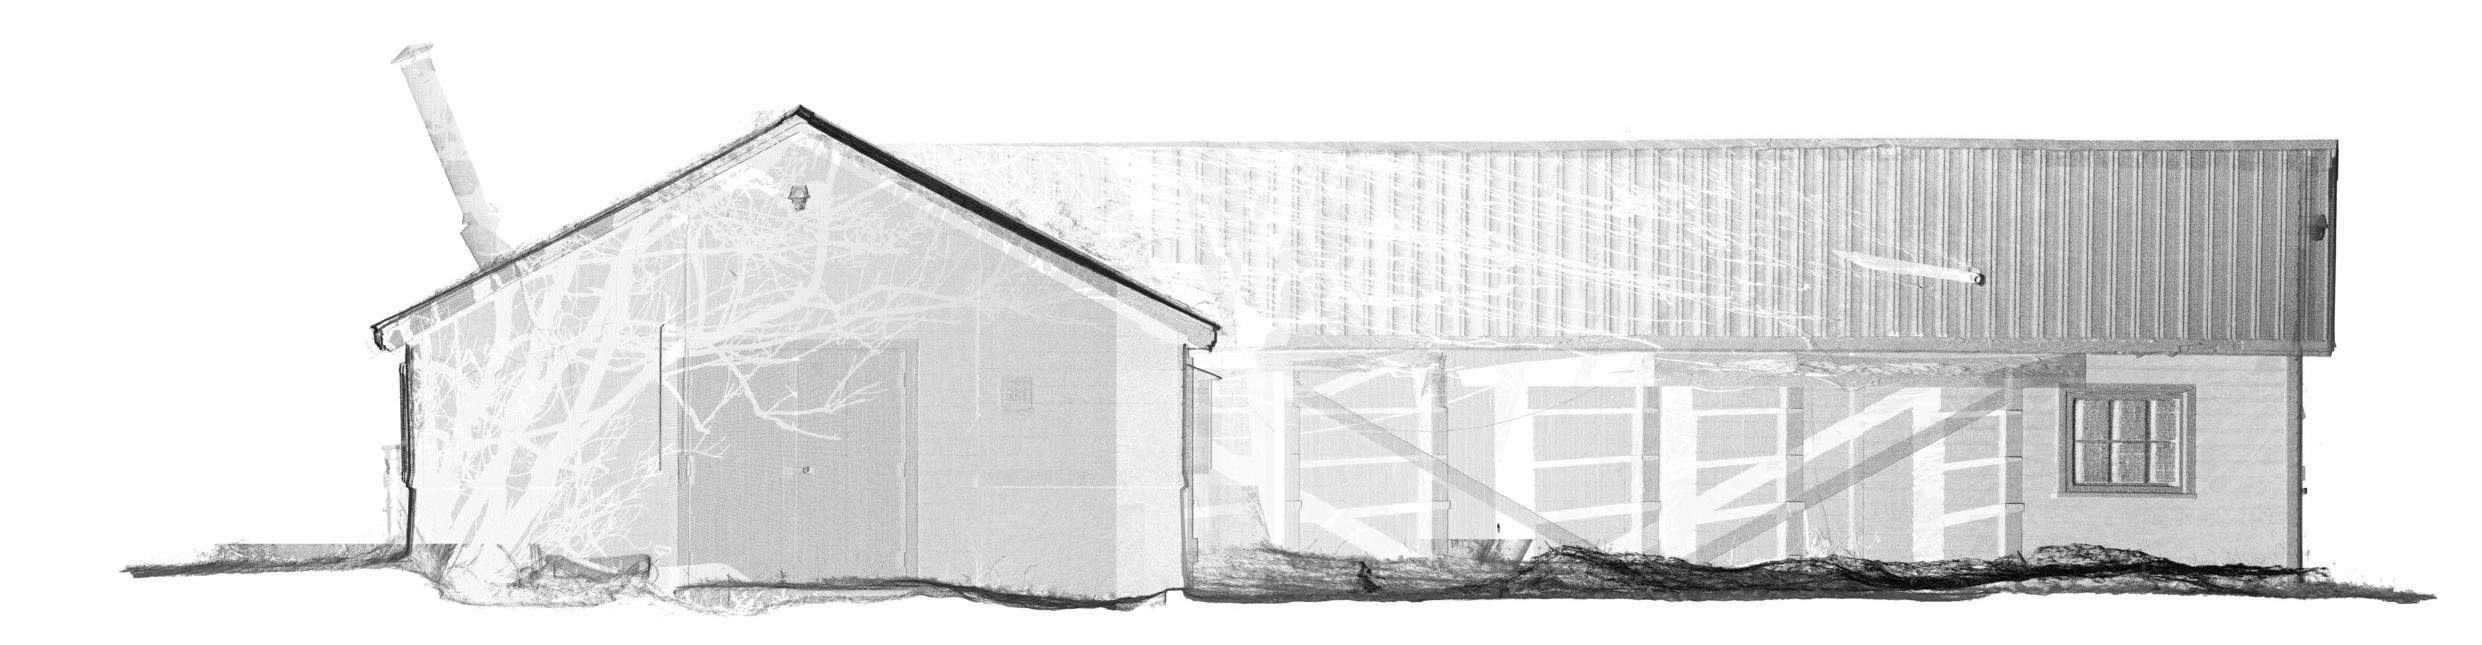


 $\left(\begin{array}{c} 1 \end{array}\right)$

NORTH ELEVATION


3/8" = 1' SCALE A

*NOTE: BUILDING ALIGNED TO PLAN NORTH (NEIGHBORHOOD GRID)

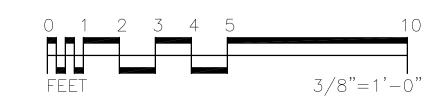

SHEET NOTES

DESIGNED:	SUB SHEET NO.	Wireless Station	DRAWING NO.
CCL TECH. REVIEW:	17	"T—Shaped" Building North Elevation	PMIS/PKG NO.
JMW	• /		SHEET
DATE: 5/4/2018		Anchorage, ALASKA	7 of 14

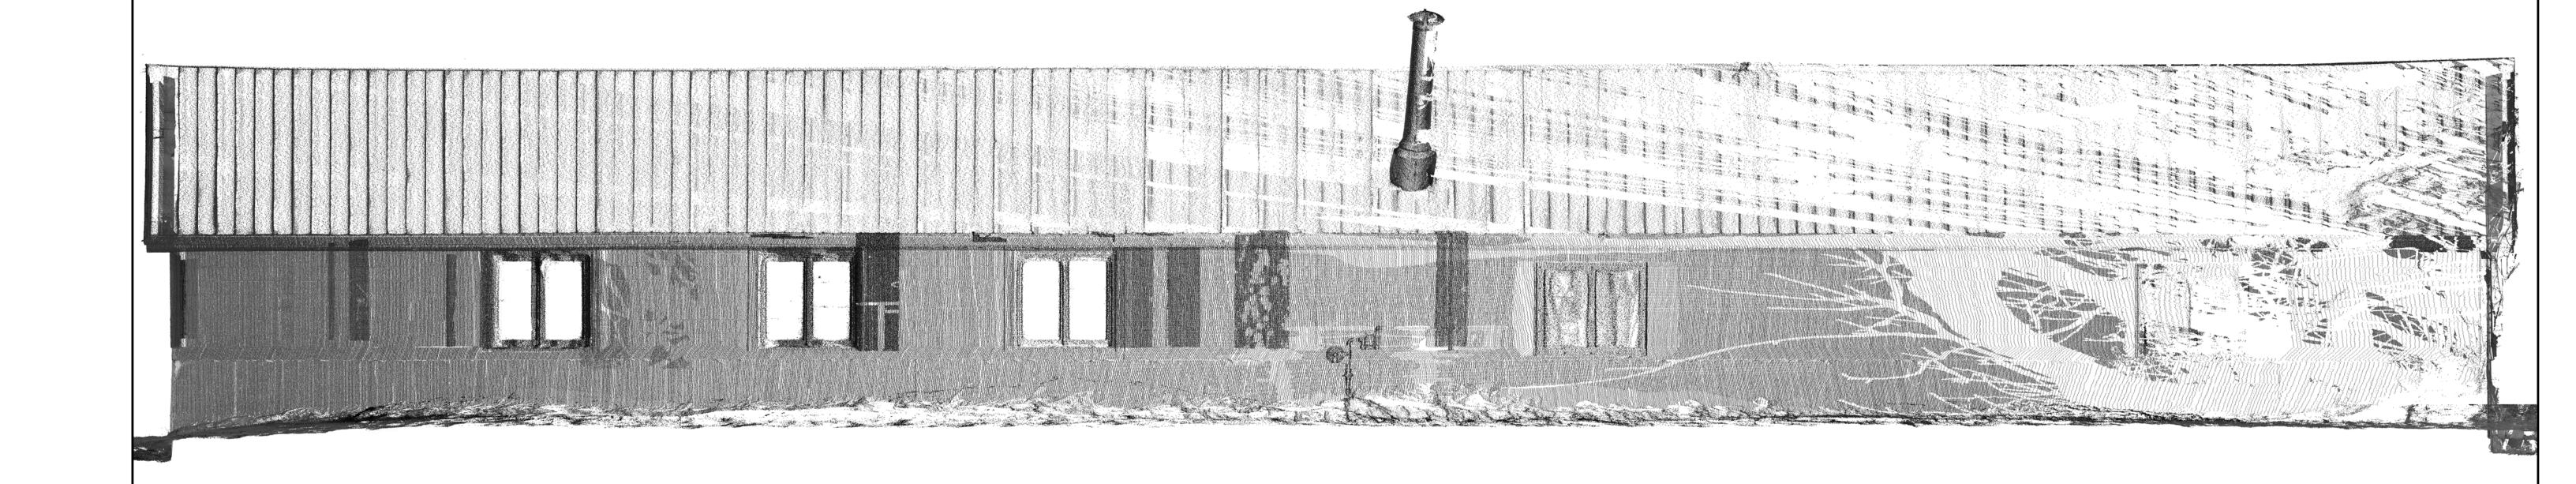


1)-

EAST ELEVATION

3/8" = 1' SCALE A

*NOTE: BUILDING ALIGNED TO PLAN NORTH (NEIGHBORHOOD GRID)

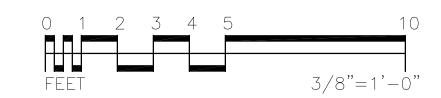

SHEET NOTES

DESIGNED:	SUB SHEET NO.	Wireless Station	DRAWING NO.
		"T-Shaped" Building	
CCL	10	1—Shaped building	PMIS/PKG NO.
TECH. REVIEW:		East Elevation	
JMW			SHEET
DATE: 5/4/2018		Anchorage, ALASKA	<u>8</u> of <u>14</u>




(1)

SOUTH ELEVATION


3/8" = 1' SCALE A

*NOTE: BUILDING ALIGNED TO PLAN NORTH (NEIGHBORHOOD GRID)

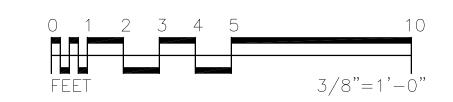

SHEET NOTES


DESIGNED:	SUB SHEET NO.	Wireless Station	DRAWING NO.
CCL TECH. REVIEW:	1 0	"T—Shaped" Building South Elevation	PMIS/PKG NO.
JMW		Journ Lievation	SHEET
DATE: 5/4/2018		Anchorage, ALASKA	<u>9</u> of 14

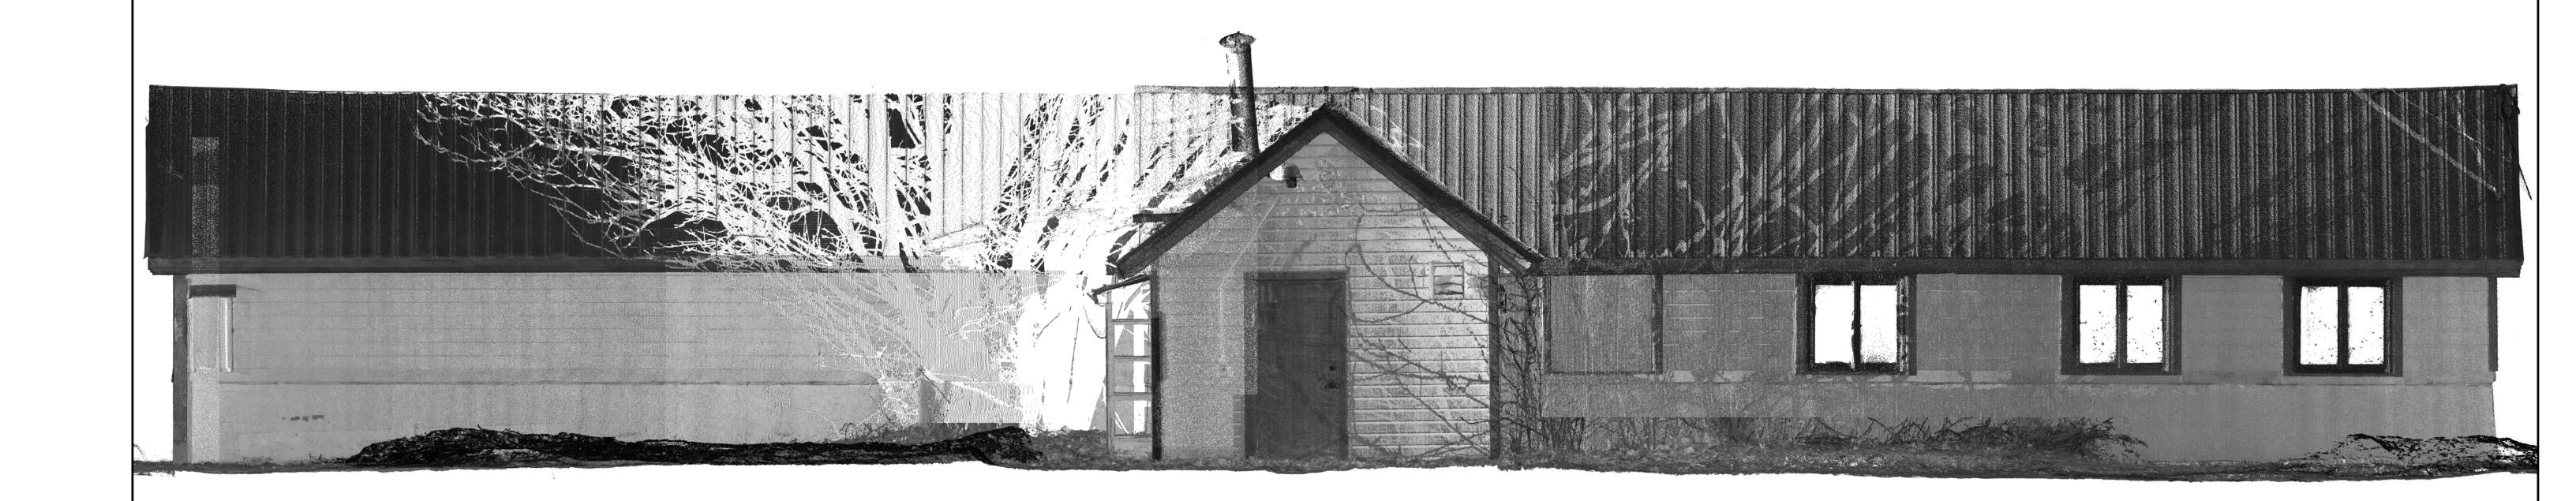

WEST ELEVATION

3/8" = 1' SCALE A

*NOTE: BUILDING ALIGNED TO PLAN NORTH (NEIGHBORHOOD GRID)

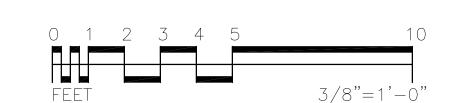


SHEET NOTES

	1		
DESIGNED:	SUB SHEET NO.	Wireless Station	DRAWING NO.
		Wilcicss Station	
		"T-Shaped" Building	
CCL		1-Shapea building	PMIS/PKG NO.
TECH. REVIEW:		West Elevation	
JMW	\bigcup \subseteq \bullet \bigcup	West Lievation	SHEET
DATE: 5/4/2018		Anchorage, ALASKA	10 of 14






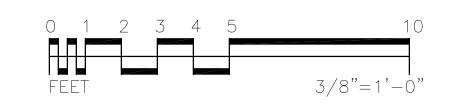

SHEET NOTES

ESIGNED:	SUB SHEET NO.	Wireless Station	DRAWING NO.
CL Ch. Review:) 1	Auxiliary Building North Elevation	PMIS/PKG NO.
ИW]	North Lievation	SHEET
ATE: 5/4/2018		Anchorage, ALASKA	11 of 14

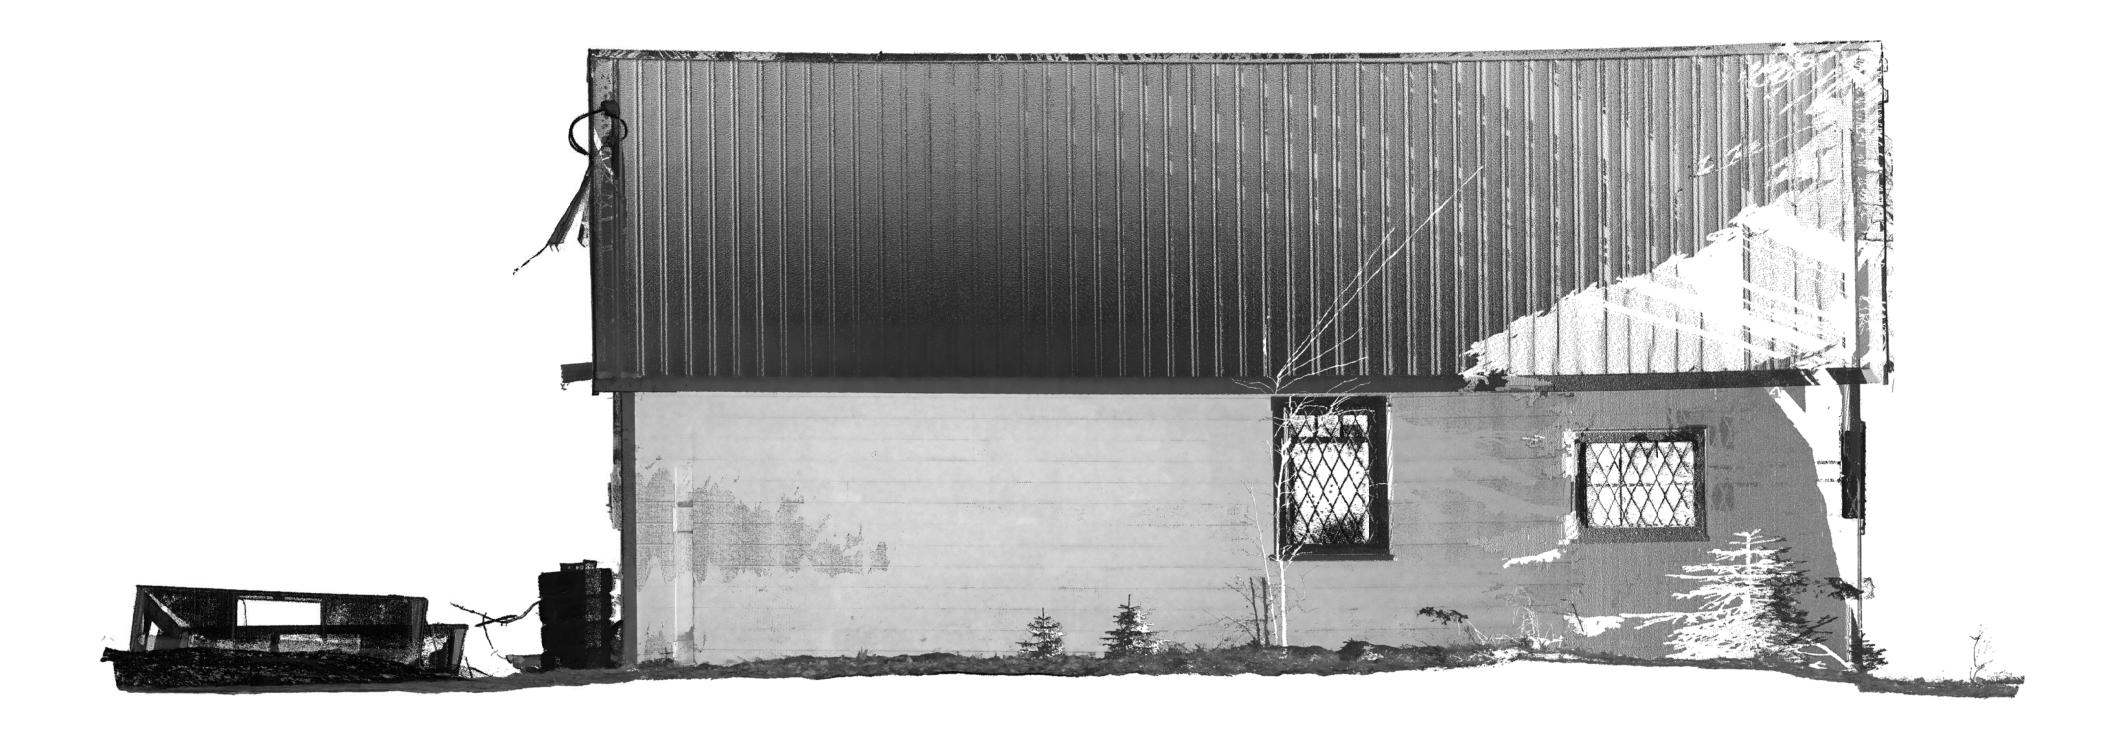




EAST ELEVATION

3/8" = 1' SCALE A

*NOTE: BUILDING ALIGNED TO PLAN NORTH (NEIGHBORHOOD GRID)

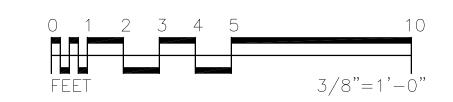

SHEET NOTES


DESIGNED:	SUB SHEET NO.	Wireless Station	DRAWING NO.
CCL TECH. REVIEW:	7 7	Auxiliary Building East Elevation	PMIS/PKG NO.
JMW		LUST LIEVUTION	SHEET
DATE: 5/4/2018		Anchorage, ALASKA	12 of 14



SOUTH ELEVATION


3/8" = 1' SCALE A

*NOTE: BUILDING ALIGNED TO PLAN NORTH (NEIGHBORHOOD GRID)

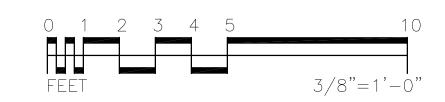

SHEET NOTES


DESIGNED:	SUB SHEET NO.	Wireless Station	DRAWING NO
CCL	$] \cap 7$	Auxiliary Building	PMIS/PKG N
TECH. REVIEW: JMW	$ \angle.\rangle$	South Elevation	SHEET
DATE: 5/4/2018		Anchorage, ALASKA	13 of 1

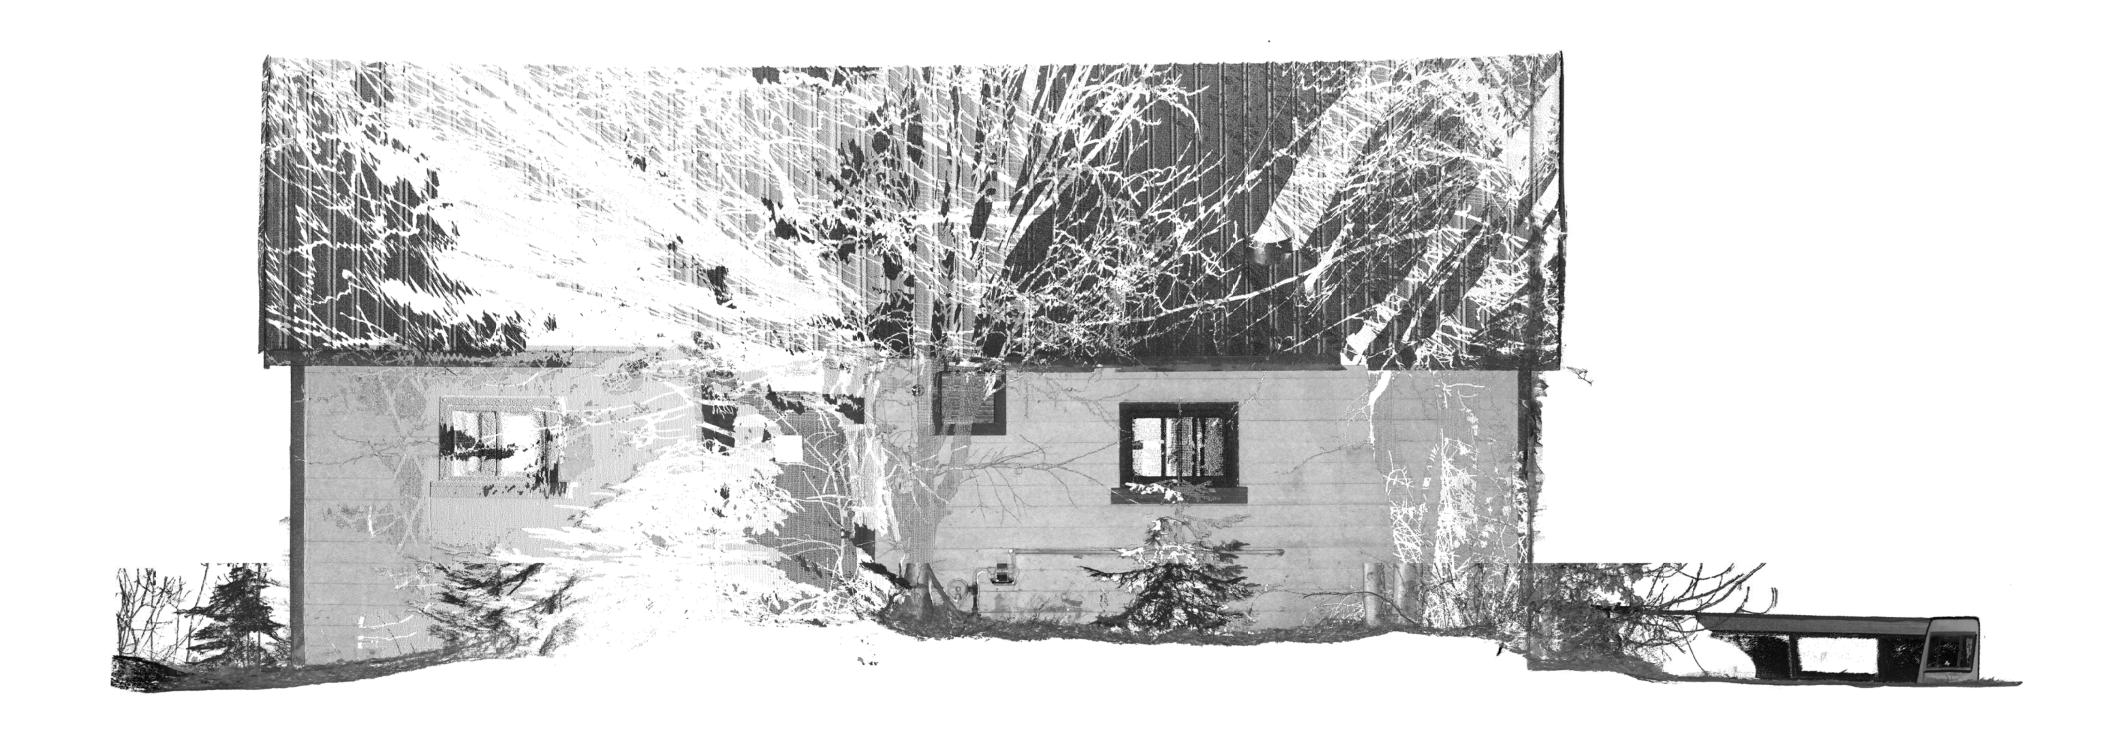

WEST ELEVATION

3/8" = 1' SCALE A

*NOTE: BUILDING ALIGNED TO PLAN NORTH (NEIGHBORHOOD GRID)

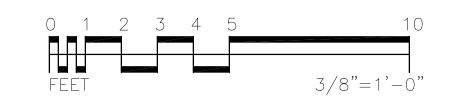

SHEET NOTES

1. NOTE THIS IS POINT CLOUD DATA DERIVED FROM A HIGH DEFINITION LASER SCANNER. SOME PORTIONS OF BUILDINGS WERE OBSCURED BY NEARBY VEGETATION AND AS A RESULT, CREATE THE APPEARANCE OF "SHADOWS" CAST AGAINST THE BUILDING'S SURFACES. THIS IS A COMMON CHARACTERISTIC OF LASER SCAN DATA AND IT SHOULD NOT BE MISINTERPRETED AS PHYSICAL FEATURES OF THE BUILDINGS.

DESIGNED:	SUB SHEET NO.	Wireless Station
CCL		Auxiliary Building
TECH. REV	/IEW:	West Elevation
DATE: 5/4/2	018	Anchorage, ALASKA

DRAWING NO. PMIS/PKG NO. SHEET 14 of 14